




EAST (FRONT) ELEVATION

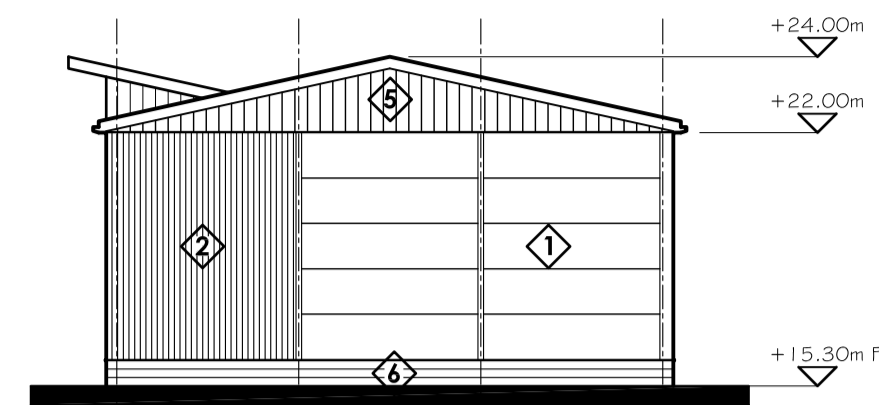


NORTH ELEVATION

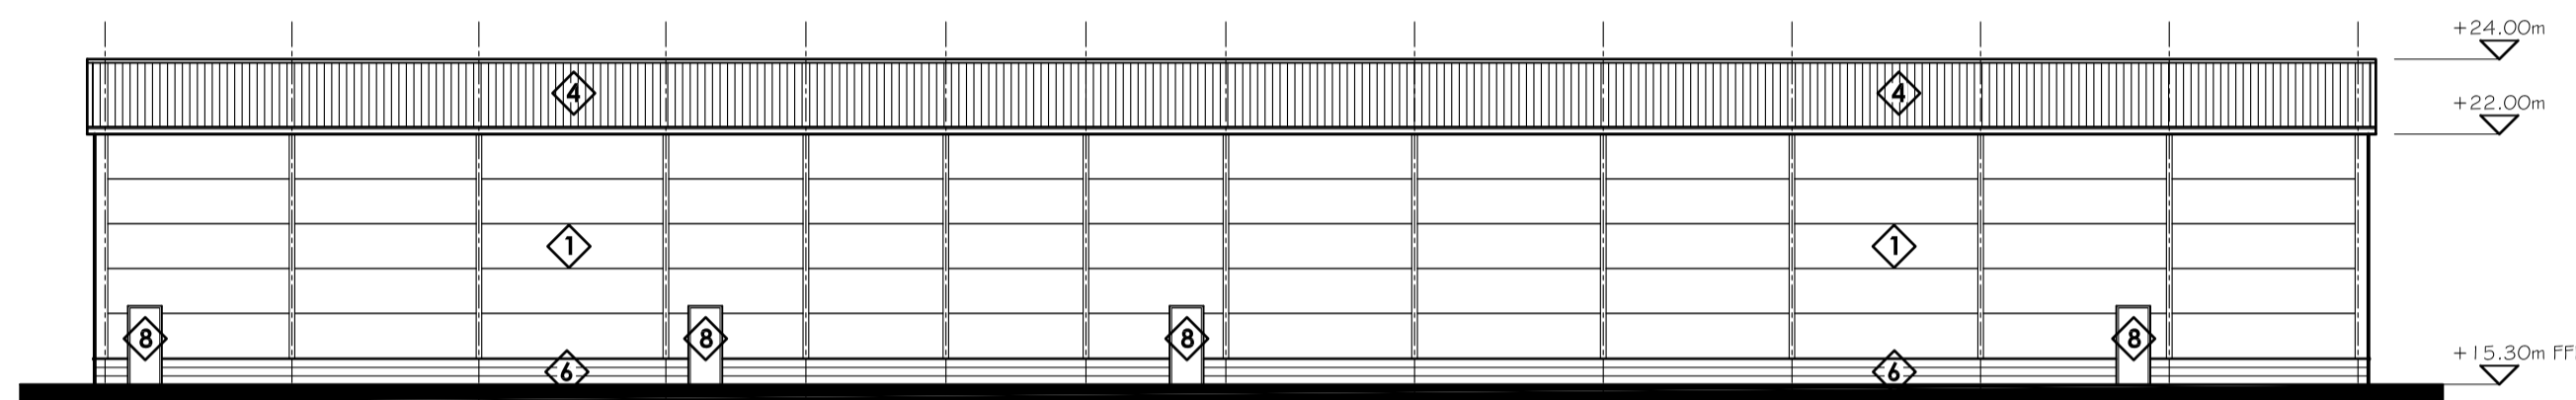


WEST (REAR) ELEVATION

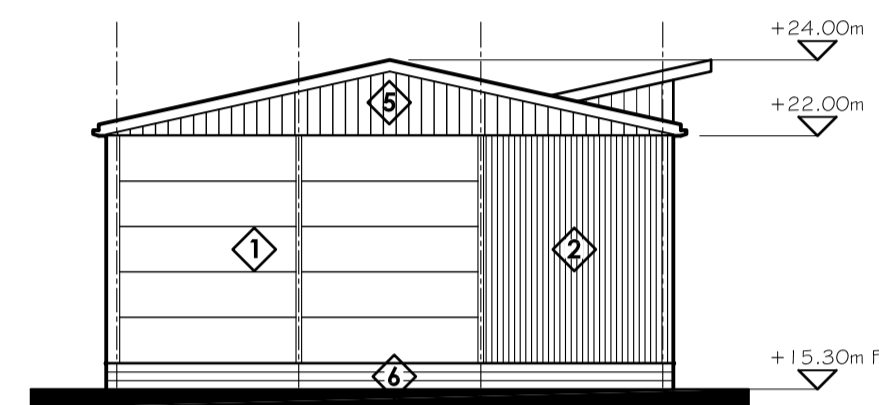


SOUTH ELEVATION

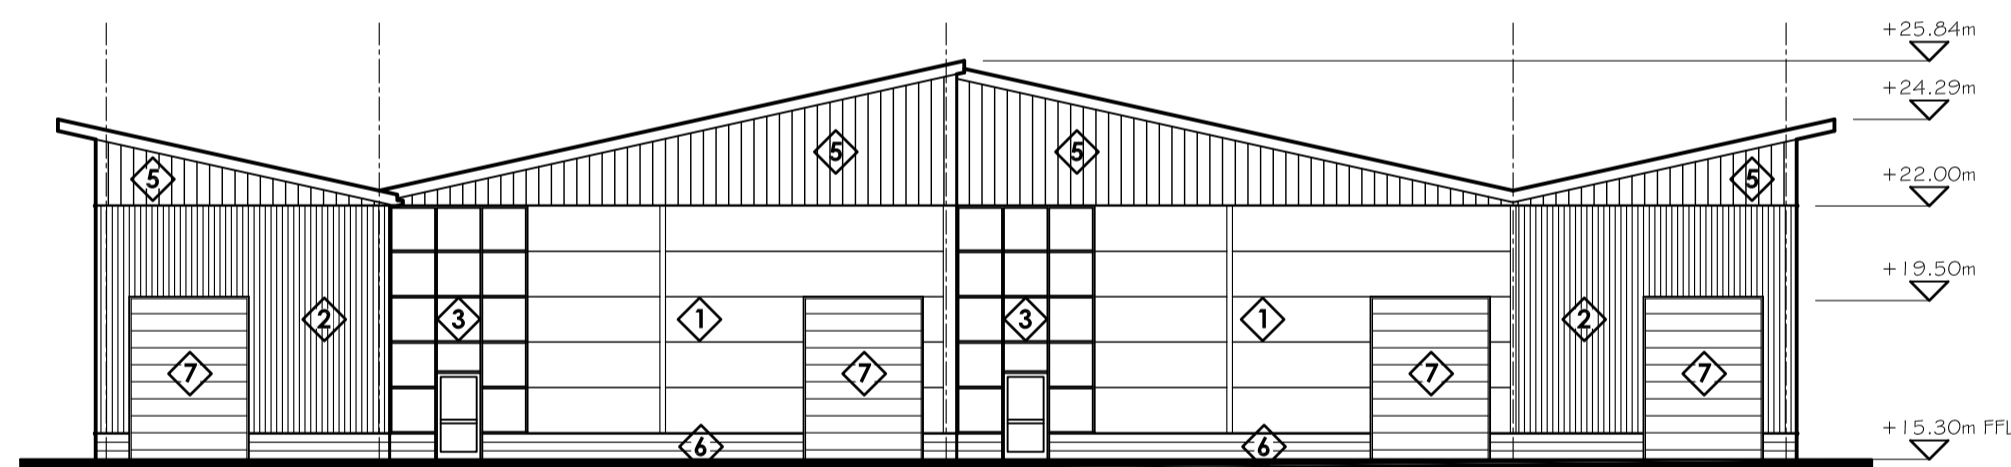


NORTH (FRONT) ELEVATION

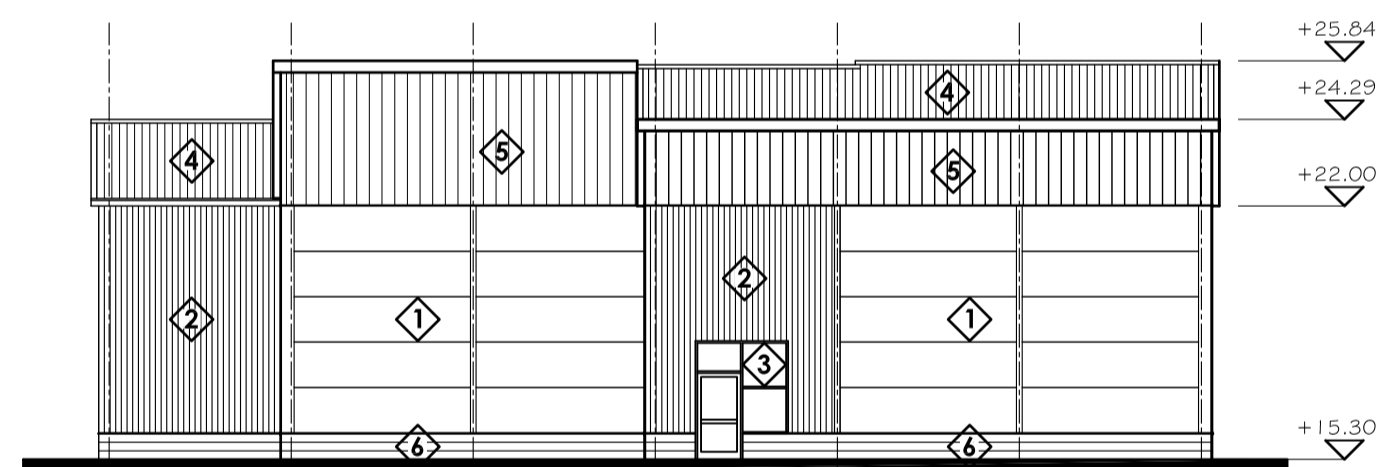


WEST ELEVATION

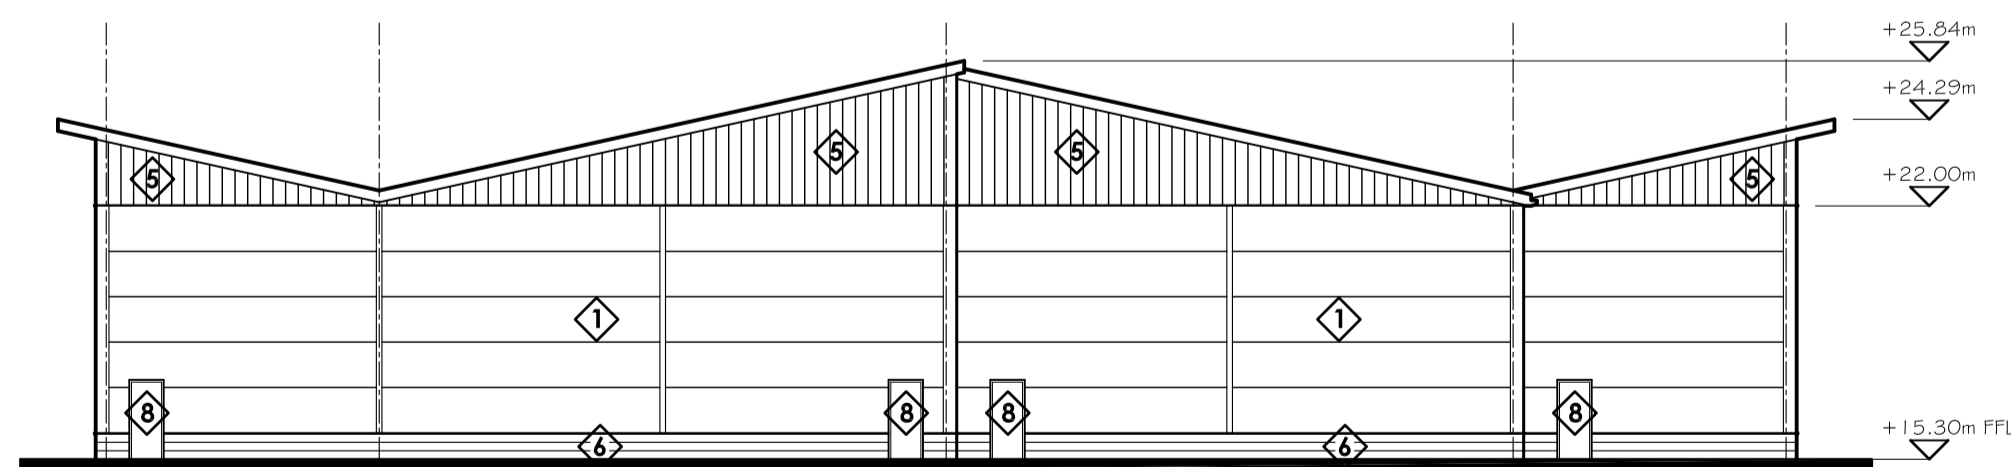

SOUTH (REAR) ELEVATION

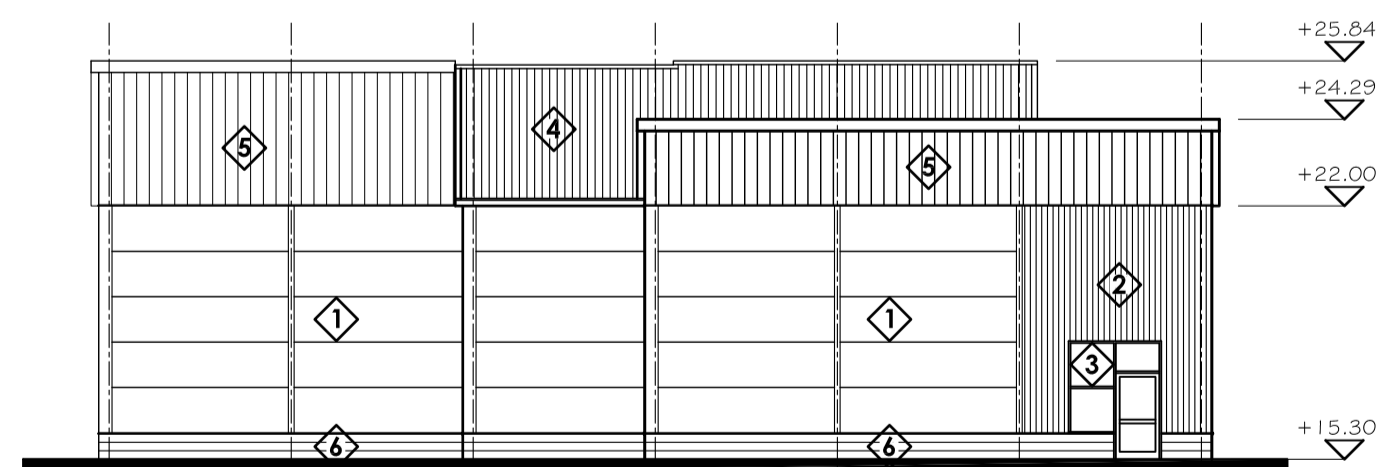

EAST ELEVATION

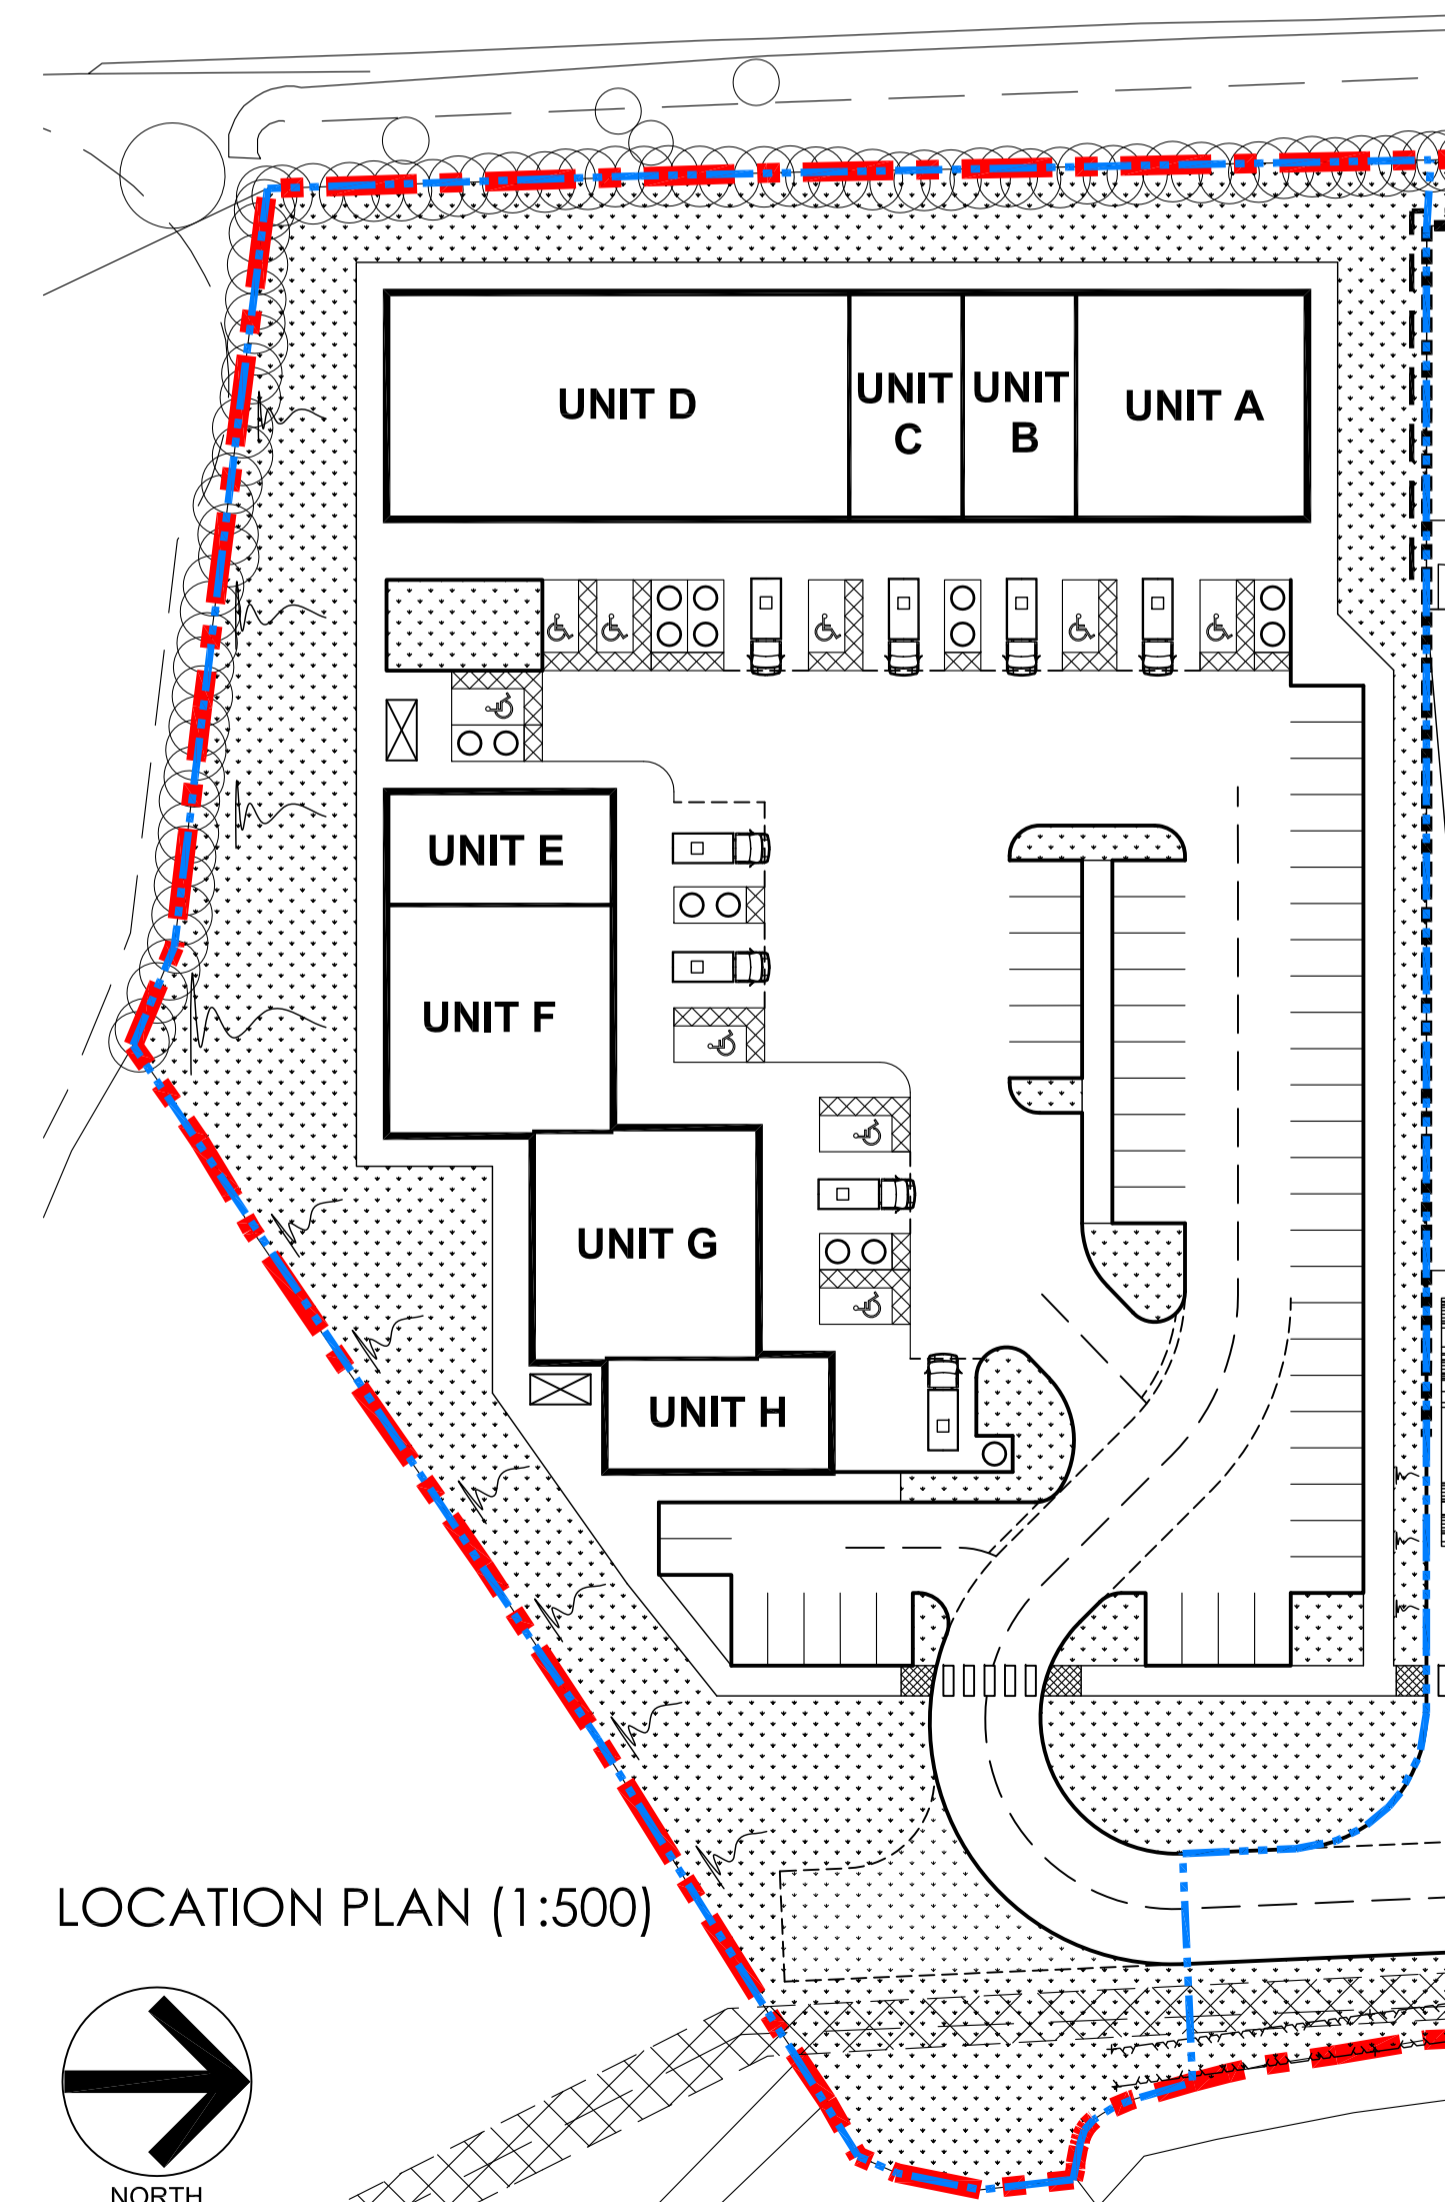

LOCATION PLAN (1:500)

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The Contractor is to check and verify all building and site dimensions, levels and sewer invert levels at connection points before work starts. The Contractor is to comply in all respects with current Building Legislation, British Standard Specifications, Building Regulations, Construction (Design & Management) Regulations, Party Wall Act etc, whether or not specifically stated on this drawing. This drawing must be read with and checked against any structural, geotechnical or other specialist documentation provided.

This drawing is not intended to show details of foundations, ground conditions or ground contaminants. Each area of ground relied upon to support any structure designed (including drainage) must be investigated by the Contractor. A suitable method of foundation should be provided allowing for existing ground conditions. Any excavations or flat ground, contaminants on or within the ground should be further investigated by a suitable expert. Any earthwork constructions shown indicate typical slopes for guidance only & should be further investigated by a suitable expert.

Where existing trees are to be retained they should be subject to a full Arboricultural Inspection for safety. All trees are to be planted so as to ensure they are a minimum of 5 metres from buildings and 3 metres from drains and services. A suitable method of foundation is to be provided to accommodate the proposed tree planting.

Sketch proposals are for illustrative purposes only & as such are subject to detailed site investigation including ground conditions/contaminants, drainage, design & planning/conservation regulations. Sketch proposals may be based upon enlargements of D10 sheets & visual estimations of existing site features, accuracy will therefore need to be verified by survey. Sketch proposals have not been considered in respect of CDM Regulations.

NOTES & REFERENCE:


This drawing should be read in conjunction with

KEY TO FINISHES:

The proposed exterior store finishes are illustrated by the following legends:

- 1 COMPOSITE WALL CLADDING PANELS, smooth light grey finish.
- 2 'RAINSCREEN TYPE' OPEN VERTICAL TIMBER WALL CLADDING, vertically fixed to battens over composite panels.
- 3 CURTAIN WALL GLAZING, comprising PPC aluminium sections, colour: grey, with tinted ' Pilkington' double glazed units.
- 4 STANDING SEAM ROOF, comprising aluminium 'Kalzip' or similar roof finish system, colour: natural silver finish.
- 5 VERTICAL WALL CLADDING PANELS, lightly profiled grey finish.
- 6 BLOCKWORK PLINTH, external quality smooth fair faced finish.
- 7 ROLLER SHUTTER, galvanised finish.
- 8 FIRE EXIT DOOR, Metal faced, colour light grey.

Revisions:	Date:	Amendment:	Name:	Checked:

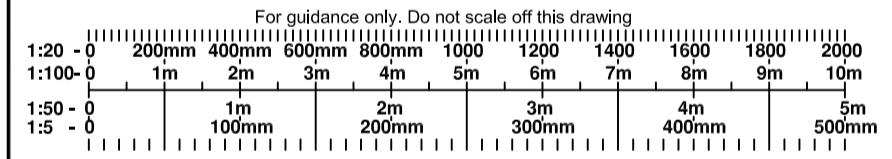

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Client: ASDA
 Project: NEW ASDA STORE: MARSH LANE, HAYLE.
 Title: PROPOSED ELEVATIONS RESIDUAL SITE B1 DEVELOPMENT.
 Status: Planning Application Checked: MP
 Drawn: P. Woodall Date: 15:07:2010 Scale: 1:200@A1
 Drawing Ref:

Job No: AAR4807 Drg No: PL-36 Rev:

Architects Engineers Surveyors
 Landscape Architects Services Consultants

ELEVATIONS AS PROPOSED